

VICINITY MAP N.T.S.

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SAU #47 JAFFREY-RINDGE COOPERATIVE SCHOOL DISTRICT ONE CONANT WAY, JAFFREY, NH 03452

RINDGE MEMORIAL SCHOOL PARKING LOT ADDITION 58 SCHOOL STREET, RINDGE NH




PLANNING BOARD REVIEW May, 2021

DESIGNED AND ENGINEERED BY:



The H.L. Turner Group Inc. 27 Locke Rd. Concord, New Hampshire 03301 t:603.228.1122 hlturner.com ARCHITECTS • ENGINEERS • BUILDING SCIENTISTS CONCORD NH • HARRISON ME • LYNDONVILLE VT

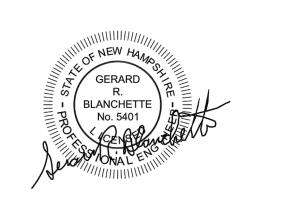

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C5	UTILITY DETAILS

OWNER & APPLICANT:	SAU #47, JAFFREY-RINDGE COOPERATIVE SCHOOL DISTRICT
ENGINEER & ARCHITECT:	THE H.L. TURNER GROUP INC. 27 LOCKE ROAD CONCORD, NH 03301
SURVEYOR:	PAQUIN LAND SURVEYING, PLLC 136 CREST VIEW DRIVE JAFFREY, NH 03452

LEGEND				
ENGINEERING			GENERAL CULTURE	
PROPOSED	EXISTING	DESCRIPTION	PROPOSED	EXISTING
212	212	CONTOUR INTERVALS		
• 212.3	X 212.3	SPOT ELEVATIONS		
R=5'		LENGTH OF RADIUS DESCRIPTION		
BOUNDARIES				
PROPOSED	EXISTING	DESCRIPTION PROPERTY LINES	<u>_</u>	
		SETBACK LINE		
		- RIGHT-OF-WAY	(4)	
EOP		- EDGE OF PAVEMENT	(4)	
EOG		EDGE OF GRAVEL	R	
		VERTICAL GRANITE CURBING		
	00000000	STONE WALL	A	
-00	00	CHAIN LINK FENCE	(RR)	
		HANDRAIL	\sim	
	O	IRON PIPE OR REBAR	(RS)	
		GRANITE OR CONCRETE BOUND	\sim	
	CG	ZONING BOUNDARY	PM	

ZONING BOUNDARY

-- -- -- EDGE OF WATER

_____ _ _ _ NCRC SOILS BOUNDARY

UTILITIES

300B

RP

SP

PROPOSED	EXISTING	DESCRIPTION		Ē
	Q	UTILITY POLE		
		CATCH BASIN		0
S	S	SEWER MANHOLE		
Ď	\bigcirc	DRAIN MANHOLE		
C	@	SUBMERSIBLE PUMP STATION MONITORING WELL	C4 - SH	PICAL SECTION NUM
	# <u>5</u> 0	WATER SHUTOFF	St	ECTION
	GV	GAS SHUTOFF	5 - F	LAN NUMBER
	~~~~~~~~~~~~~~~~~~~~~~~~~~~~~~~~~~~~~~~	FIRE HYDRANT	(C3.3) - 5	SHEET LOCATION OF
₽ ¤	¢	LIGHT POLE	-	
D	SD	DRAIN LINE		CROSS-SECTION NUM
S	<i>S</i>			SHEET WHERE CROSS S SHOWN
FD		FOUNDATION DRAIN		
SD		SURFACE DRAIN		DETAIL NUMBER
——— w ———	<i>W</i>		C7 C2	SHEET SERIES WHERE S SHOWN
G	G	— GAS LINE		SHEET WHERE DETAIL S SHOWN
	<i>OH</i>			
E	<i>E</i>	UNDERGROUND ELECTRIC LINE		
₽ ¢	¢	SITE LIGHT FIXTURES		
		WALL MOUNTED LIGHT		

#### EROSION CONTROL

			ADL
PROPOSED	EXISTING	DESCRIPTION	Gener
<del>           </del>		SILTATION FENCING/ SILTSOX	ABAN ACR
<b>oo</b>		CONSTRUCTION FENCING	ADJ APPR
			BC



#### **ABBREVIATIONS**

General	
ABAN	Abandon
ACR	Accessible Curb Ramp
ADJ	Adjust
APPROX	Approximate
BC	Bituminous Curb
BOS	Bottom Of Slope
CCB	Cape Cod Berm
ELEV	Elevation
EXIST	Existing
FDN	Foundation
MAX	Maximum
MIN	Minimum
NIC	Not In Contract
NTS	Not To Scale
PCC	Precast Concrete Curb
PROP	Proposed
PSI	Pounds Per Square Inch
RAP	Reclaimed Asphalt Pavement
R&R	Remove And Reset
R&S	Remove And Stack
REM	Remove
REMOD	Remodel
RET	Retain
SDYL SGC	Silod Double Yellow Line Sloped Granite Curb
SP	Sawcut Pavement
SSWL	Single Solid White Line
TOS	Top Of Slope
TOW	Top Of Wall
TYP	Typical
UNO	Unless Noted Otherwise
VGC	Vertical Granite Curb
VIF	Verify In Field
	,

		SURVEY NOTES	SITE NC
		1. SURVEY BY PAQUIN LAND SURVEYING,PLLC, DATED JULY 13, 2017 FOR THE SAU #47.	1. IT SHALL B
EXISTING	DESCRIPTION	2. THE ENGINEER MAKES NO GUARANTEE THAT THE UNDERGROUND UTILITIES DEPICTED COMPRISE ALL SUCH UTILITIES IN THE AREA, EITHER IN SERVICE OR ABANDONED.	SITE AND A SHALL ADVI HOURS IN A
	TREES	CONTRACTOR SHOULD NOTIFY, IN WRITING, ANY UTILITY COMPANY AND APPROPRIATE GOVERNMENTAL AGENCIES PRIOR TO ANY EXCAVATION WORK AND CALL DIG-SAFE AT 1-888-344-7233.	2. LIMITS OF V ALL WORK
	TREELINE		CURBING, S 3. THE CONTR
	SIGNS & SYMBOLS		AND NATION
	CONCRETE FILLED STEEL BOLLARD	<u>GENERAL NOTES</u>	4. ALL EXCAVA CONTRACTO
	PARKING SPACE COUNT	<ol> <li>THE CONTRACTOR IS RESPONSIBLE FOR THE MEANS AND METHODS OF CONSTRUCTION AND FOR CONDITIONS AT THE SITE. THESE PLANS, PREPARED BY THE H.L. TURNER GROUP INC., DO NOT EXTEND TO OR INCLUDE SYSTEMS PERTAINING TO THE SAFETY OF THE CONSTRUCTION CONTRACTOR OR HIS EMPLOYEES, AGENTS OR REPRESENTATIVES IN</li> </ol>	5. THE ENGINE GRADING, IF 6. THE CONTR
	REMOVE	THE PERFORMANCE OF THE WORK. THE SEAL OF THE ARCHITECT OR ENGINEER HEREON DOES NOT EXTEND TO ANY SUCH SAFETY SYSTEMS THAT MAY NOW OR HEREAFTER BE INCORPORATED INTO THESE PLANS. THE CONSTRUCTION CONTRACTOR SHALL PREPARE	THEIR WORI 7. EXTERIOR D
	ABANDON IN PLACE	OR OBTAIN THE APPROPRIATE SAFETY SYSTEMS THAT MAY BE REQUIRED BY THE U.S. OCCUPATIONAL SAFETY AND HEALTH ADMINISTRATION (OSHA) AND/OR LOCAL	8. WRITTEN DII
	REMOVE AND RESET	REGULATIONS. 2. THIS PROJECT IS TO BE CONSTRUCTED IN ACCORDANCE WITH THE FOLLOWING: A.) THE	SHALL USE BETWEEN TI ENGINEER S
	REMOVE AND RESET	LATEST EDITION OF THE STATE OF NEW HAMPSHIRE DEPARTMENT OF TRANSPORTATION STANDARD SPECIFICATIONS FOR ROAD AND BRIDGE CONSTRUCTION, AND ALL SUPPLEMENTS. B.) STORMWATER MANUAL VOLUMES 1–3 BY THE NH DEPT. OF ENVIRONMENTAL SERVICES. C.) THE LATEST EDITION OF THE TOWN OF RINDGE	9. SITE WORK FEATURES A CONFLICT W
	PROTECT AND MAINTAIN	CONSTRUCTION STANDARDS. 3. CONTRACTOR SHALL PROTECT AND MAINTAIN EXISTING BENCHMARKS AND BOUNDS. ALL	10. EXISTING VE
	REMOVE PAVEMENT	BENCHMARKS AND BOUNDS DISTURBED BY THE CONTRACTOR, WHETHER THEY BE PRIVATE PROPERTY CORNERS OR HIGHWAY RIGHT OF WAY BOUNDS, SHALL BE REESTABLISHED BY A NEW HAMPSHIRE LICENSED LAND SURVEYOR AT NO EXPENSE TO THE TOWN OF RINDGE OR ABUTTING PROPERTY OWNERS.	11. THE AREA ( DISTURBED HOWEVER, \
<b>B</b> 1	SAWCUT PAVEMENT	4. THE CONTRACTOR IS RESPONSIBLE FOR ALL PERMITS, FEES, TEMPORARY UTILITIES AND COORDINATION WITH ALL AGENCIES IN OBTAINING ACCESS TO THE SITE AND PERFORMING ALL WORK REQUIRED FOR THIS PROJECT.	RELATED UT CASES BE OPERATIONS WITHOUT EI
$\mathbf{\Phi}$	SUBSURFACE BORING	5. THIS WORK SHALL BE CONSTRUCTED FROM A COMPLETE SET OF PLANS AND SPECIFICATIONS.	THAN 24 H OR OTHER AS NEEDED
TP1	TEST PIT	6. THE CONTRACTOR IS RESPONSIBLE FOR THE COORDINATION AND PROVISION OF ALL TRAFFIC AND PEDESTRIAN CONTROL AND SAFETY FOR THE DURATION OF THIS PROJECT.	DISTURB AR WITHIN 72
Ē	ELECTRIC BOX	7. VERIFY TBM ELEVATIONS PRIOR TO CONSTRUCTION.	12. TOPSOIL ST THE OWNER
0	POST		13. CONTRACTC
		GENERAL CONSTRUCTION SEQUENCE NOTES	OCCURRED RESULT OF OWNER ANE
SECTION NUMBER	SURFACE TREATMENT	<ol> <li>THE FOLLOWING IS THE ENGINEER'S RECOMMENDED CONSTRUCTION SEQUENCE. THE CONTRACTOR SHALL SUBMIT A DETAILED PROJECT SCHEDULE TO THE OWNER AND ENGINEER PRIOR TO THE COMMENCEMENT OF WORK. PROJECT SCHEDULE IS ULTIMATELY THE CONTRACTOR'S RESPONSIBILITY.</li> </ol>	UTILITY
JMBER		2. INSTALL SILT FENCING AND OTHER FILTRATION BARRIERS, INLET PROTECTION, STABILIZED CONSTRUCTION EXIT(S), AND EROSION PREVENTION MEASURES PRIOR TO THE START OF ANY EARTH MOVING OPERATION; MEASURES ARE TO BE MAINTAINED UNTIL FINAL PAVEMENT SURFACING AND LANDSCAPING AREAS ARE ESTABLISHED.	1. THE CONTR LOCATION, THESE PLA
OCATION OF ED PLAN	ENLARGED PLAN	3. DELINEATE CONSTRUCTION LIMITS.	NOTIFIED IN CONSTRUCT
SECTION NUMBER		<ol> <li>STRIP AND STOCKPILE LOAM AND EXCESS EARTH MATERIAL TO BE SAVED. STABILIZE STOCKPILE(S) AS NECESSARY. COORDINATE STAGING AND STOCKPILE LOCATIONS WITH THE OWNER.</li> </ol>	ENGINEER E RESPONSIBI INCLUDING THE SITE.
VHERE CROSS-SECTI /N	CROSS-SECTION ON	5. PRIOR TO COMMENCING ROUGH GRADING, CONSTRUCT AND STABILIZE TEMPORARY DETENTION PONDS, SWALES, AND OTHER STORMWATER CONVEYANCES. ENSURE THE SOIL IN THESE DISTURBED AREAS IS STABILIZED PRIOR TO DIRECTING RUNOFF OR STORMWATER DISCHARGES INTO AND THROUGH THE MEASURES.	THE PUBLIC 2. THE CONTR OVERHEAD
NUMBER SERIES WHERE DETAI N	L DETAIL	6. ROUGH GRADE SITE. THE CONTRACTOR SHALL BE RESPONSIBLE FOR ENSURING THE GRADING ALLOWS SURFACE RUN—OFF TO FLOW FROM UNSTABILIZED AREAS TOWARDS STABILIZED AREAS AND TOWARD THE PROTECTIVE MEASURES FOR SEDIMENT RETENTION.	WITH THE U RESPONSIBI 3. PROPOSED
VHERE DETAIL /N		7. EXCAVATE AND INSTALL SITE UTILITIES OUTSIDE OF BUILDING FOOTPRINT.	ELEVATIONS ADJUST ALI TO FINISHE
		<ol> <li>PERFORM FINE GRADING ACROSS SITE. PLACE PAVEMENTS AND HARDSCAPING AND ENSURE ALL DISTURBED AREAS OUTSIDE OF PAVEMENT ARE LOAMED, SEEDED AND STABILIZED.</li> </ol>	4. IF APPLICA
		<ol> <li>AFTER ALL AREAS HAVE BEEN STABILIZED, REMOVE ALL ACCUMULATED SEDIMENTS, FINISH GRADE, RESEED, AND APPLY HAY OR STRAW MULCH. REMOVE TEMPORARY SEDIMENTATION BASINS AND SWALES. COMPLETE FINISH GRADING AND STABILIZATION OF DISTURBED AREAS.</li> </ol>	AGENCY PR RESPECTIVE WITH THE F
		10. FINISH ANY REMAINING SITE CONSTRUCTION.	5. ALL DRAINA NOTED) SH
Landscapi	ng	11. REMOVE SILT FENCE, STONE, AND OTHER TEMPORARY EROSION CONTROL MEASURES AFTER VEGETATION IS ESTABLISHED, SILT FENCING IS TO BE CUT-OFF AT GROUND LEVEL, SO AS NOT TO DESTABILIZE THE TERRAIN DURING REMOVAL. IF THE GROUND DOES BECOME DESTABILIZED, RELOAM AND SEED. STUMP GRINDING BERMS SHALL BE REMOVED AND DISPOSED OF OFFSITE. RAKE OUT ALL REMAINING DEBRIS. PERFORM FINAL SITE	CONFIGURA SUMPS, UN EXISTING U COMMENCIN
B&B BR L&S	Balled & Burlapped Bare Root Loam And Seed	CLEAN-UP. 12. CLEAN ALL DRAINAGE STRUCTURES, PIPES, SUMPS, SWALES, AND BASINS OF ALL SILT	
Utility		AND DEBRIS.	DEMOLIT
ACCMP AD CAP CB	Asphalt Coated Corrugated Metal Pipe Acid Resistant Corrugated Aluminum Pipe Catch Basin		1. SEE SHEET
CIP CIT CMP	Cast Iron Pipe Change In Type Corrugated Metal Pipe		LANDSC.
COND DIP	Conduit Ductile Iron Pipe		1. LANDSCAF
DMH F&C F&G_	Drain Manhole Frame And Cover Frame And Grate		2. REPLANTII
ent HDPE HYD INV	High Density Polyethylene Pipe Hydrant Invert Elevation		
PE PPE	Polyethylene Pipe Polypropylene Pipe		
PPS PVC PWW RCP RGS	Prefabricated Pump Station Polyvinylchloride Pipe Paved Water Way Reinforced Concrete Pipe Rigid Galvanized Steel		
SD	Surface Drain		

SS-SECTION NU ET WHERE CROS

ET SERIES WHEF

ET WHERE DETA

SMH

UD

UP

XP

VCP

TSV&B

Sewer Manhole

Vitrified Clay Pipe

Explosion Proof

Underdrain

Utility Pole

Tapping Sleeve, Valve & Box

### SITE N<u>otes</u>

BE THE CONTRACTOR'S RESPONSIBILITY TO FAMILIARIZE THEMSELVES WITH THE ALL EXISTING CONDITIONS SURROUNDING IT AND THEREON. THE CONTRACTOR DVISE THE ENGINEER OF THEIR INTENTION TO ACCESS THE SITE AT LEAST 48 ADVANCE.

WORK ARE SHOWN AS APPROXIMATE. THE CONTRACTOR SHALL COORDINATE ( TO PROVIDE SMOOTH TRANSITIONS. THIS INCLUDES GRADING, PAVEMENT, SIDEWALKS AND ALIGNMENTS.

ITRACTOR SHALL PERFORM THE WORK IN ACCORDANCE WITH ALL LOCAL, STATE FIONAL CODES, SPECIFICATIONS, REGULATIONS AND STANDARDS.

AVATIONS SHALL BE THOROUGHLY SECURED ON A DAILY BASIS BY THE CTOR AT THE COMPLETION OF CONSTRUCTION OPERATIONS.

GINEER SHALL BE CONTACTED FOR CLARIFICATION OF SITE WORK AND/OR , IF NECESSARY.

ITRACTOR SHALL MAINTAIN EMERGENCY ACCESS TO ALL AREAS AFFECTED BY ORK AT ALL TIMES.

DIMENSIONS ARE TO THE FACE OF BUILDING UNLESS NOTED OTHERWISE.

DIMENSIONS HAVE PRECEDENCE OVER SCALED DIMENSIONS. THE CONTRACTOR ISE CAUTION WHEN SCALING REPRODUCED PLANS. IN CASE OF CONFLICT THIS PLAN SET AND ANY OTHER DRAWING AND/OR SPECIFICATION, THE SHALL BE CONTACTED IMMEDIATELY FOR CLARIFICATIONS.

RK SHALL BE CONSTRUCTED FROM A COMPLETE SET OF PLANS; NOT ALL ARE DETAILED ON EVERY PLAN. THE ENGINEER IS TO BE NOTIFIED OF ANY WITHIN THIS PLAN SET.

VEGETATION IS TO REMAIN UNDISTURBED WHEREVER POSSIBLE.

OF LAND EXPOSED AND THE TIME OF EXPOSURE SHALL BE MINIMIZED. ALL ED AREAS SHALL BE STABILIZED WITHIN 72 HOURS AFTER FINAL GRADING. WORK IN ADDITIONAL SUB PHASES MAY BE PERFORMED IF NEEDED FOR UTILITY EXTENSIONS/ CONNECTIONS OR EARTHWORK BORROW/FILL, BUT IN ALL STABILIZED WITHIN 72 HOURS AFTER UTILITIES ARE IN PLACE OR EARTHWORK ONS CEASE. IN NO CASE SHALL ANY DISTURBED AREA BE LEFT UNSTABILIZED EITHER PERMANENT OR TEMPORARY EROSION CONTROL MEASURES FOR MORE HOURS OR AS NEEDED TO ENSURE SUFFICIENT STABILIZATION DUE TO WEATHER ER CONDITIONS. SIMULTANEOUS WORK IN MULTIPLE PHASES MAY BE PERMITTED DED, SUBJECT TO THE ABOVE CRITERIA. HOWEVER, THE CONTRACTOR SHALL NOT AREAS THAT CANNOT REASONABLY BE PROPERLY STABILIZED AND MAINTAINED 2 HOURS.

STRIPPED FROM THE SITE SHALL BE STOCKPILED IN A LOCATION APPROVED BY NER. ALL TOPSOIL SHALL REMAIN THE PROPERTY OF THE OWNER.

CTOR SHALL BE RESPONSIBLE FOR THE REPAIR OF ANY DAMAGE THAT HAS ED TO EXISTING WALKWAYS, UTILITIES, BUILDINGS, STRUCTURES, ETC., AS A OF HIS ACTIVITIES. REPAIRS ARE TO BE PERFORMED AT NO COST TO THE AND TO THE SATISFACTION OF THE ENGINEER AND THE OWNER.

#### NOTES

ITRACTOR SHALL BE RESPONSIBLE FOR VERIFYING AND DETERMINING THE SIZE, AND ELEVATION OF ALL EXISTING UTILITIES, SHOWN OR NOT SHOWN ON PLANS PRIOR TO THE START OF ANY CONSTRUCTION. THE ENGINEER SHALL BE IN WRITING OF ANY UTILITIES FOUND INTERFERING WITH THE PROPOSED CTION AND APPROPRIATE REMEDIAL ACTION SHALL BE AGREED TO BY THE BEFORE PROCEEDING WITH THE WORK. THE CONTRACTOR SHALL BE SIBLE TO CONTACT "DIGSAFE" (888) 344–7233 AT LEAST 72 HOURS NOT NG WEEKENDS AND HOLIDAYS PRIOR TO INITIATING CONSTRUCTION ACTIVITIES ON THE CONTRACTOR IS ADVISED THAT DIGSAFE MAY NOT LOCATE UTILITIES OFF BLIC RIGHT-OF-WAY WHICH MAYBE PRESENT AT THIS SITE.

NTRACTOR SHALL CONTACT ALL UTILITY COMPANIES OWNING UTILITIES, EITHER AD OR UNDERGROUND, WITHIN THE CONSTRUCTION AREA AND SHALL COORDINATE UTILITY COMPANIES. THE PROTECTION OR RELOCATION OF UTILITIES IS THE SIBILITY OF THE CONTRACTOR.

ED RIM ELEVATIONS OF DRAINAGE STRUCTURES ARE APPROXIMATE. FINAL INS ARE TO BE SET FLUSH WITH FINISH GRADES UNLESS NOTED OTHERWISE. ALL OTHER RIM ELEVATIONS OF MANHOLES, WATER GATES, AND OTHER UTILITIES SHED GRADE WITHIN LIMITS OF WORK.

CABLE, THE CONTRACTOR SHALL COORDINATE WITH THE RESPECTIVE UTILITY PRIOR TO DISCONNECTING THE EXISTING SERVICE CONNECTIONS AT THEIR TIVE MAINS. THE EXISTING UTILITIES SHALL BE DISCONNECTED IN ACCORDANCE RESPECTIVE UTILITY COMPANIES' STANDARDS AND SPECIFICATIONS.

INAGE STRUCTURES INTERIOR DIAMETERS (4' MINIMUM UNLESS OTHERWISE SHALL BE DETERMINED BY THE MANUFACTURER BASED ON THE PIPE IRATIONS SHOWN ON THESE PLANS. CATCH BASINS SHALL HAVE 3-FOOT DEEP UNLESS OTHERWISE NOTED. CONTRACTOR SHALL EXCAVATE TEST PITS AT ALL UTILITY CROSSINGS TO VERIFY PIPE SIZE AND ELEVATION PRIOR TO CING UTILITY CONSTRUCTION.


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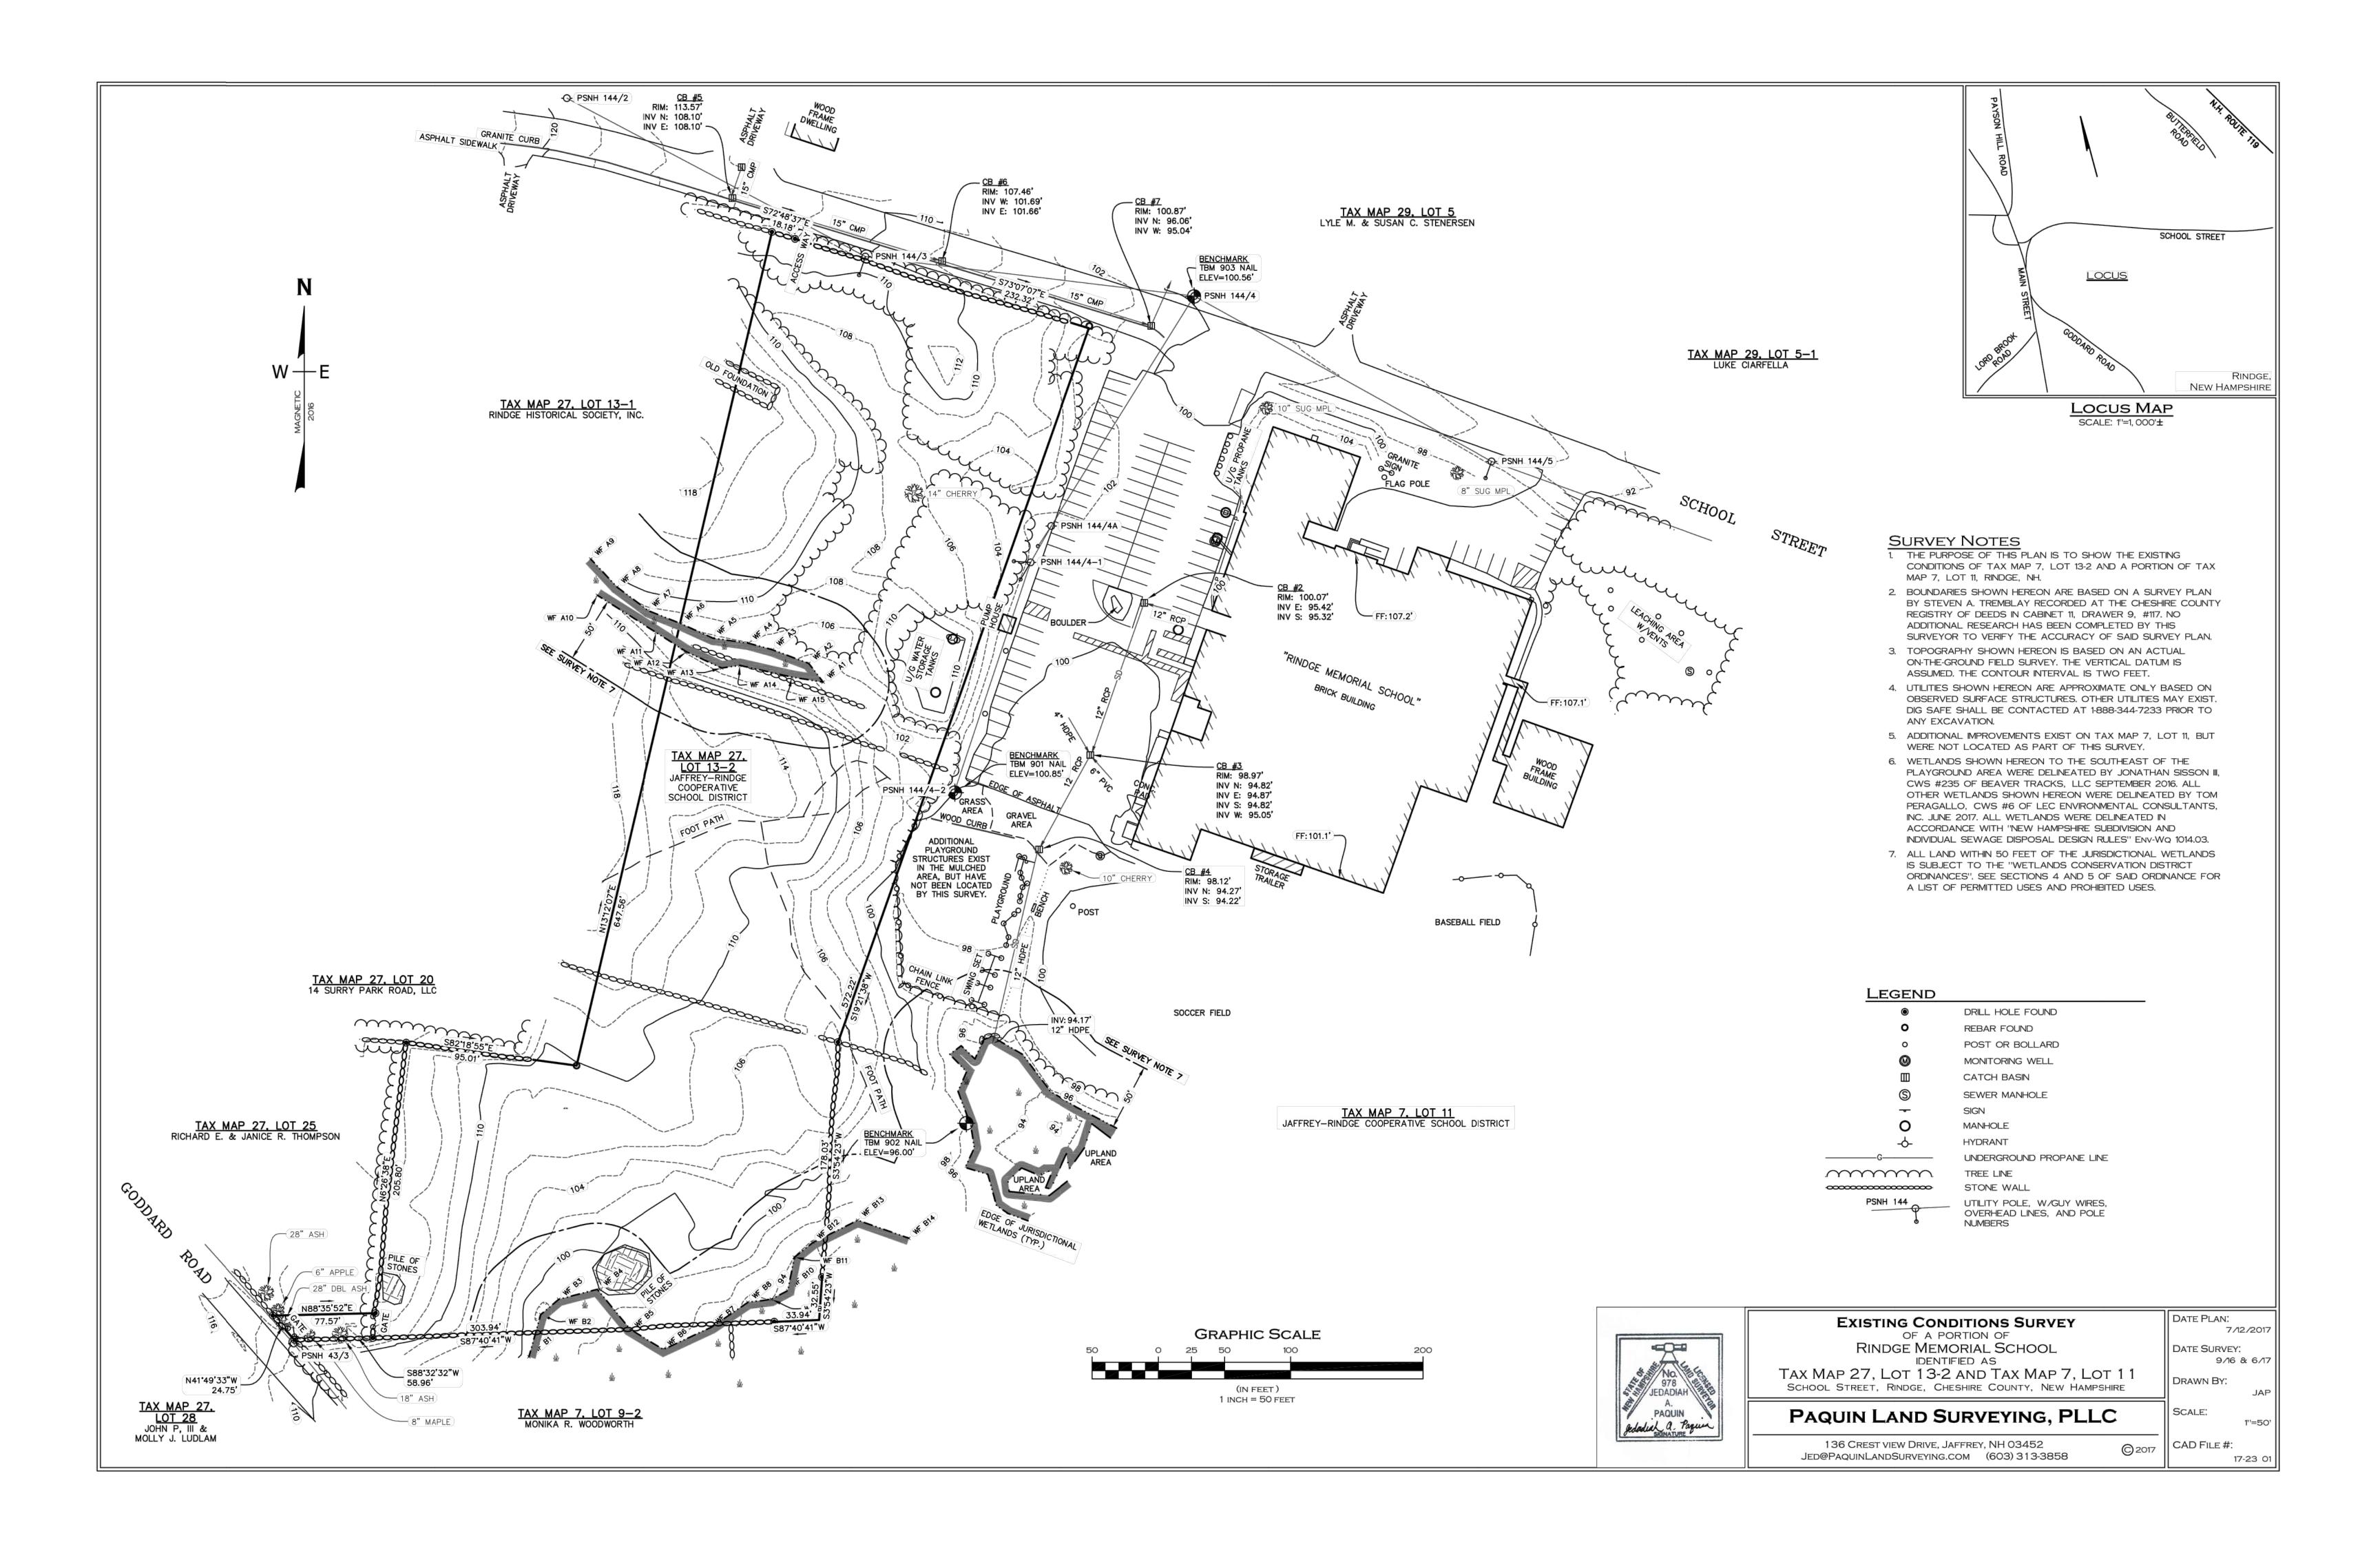
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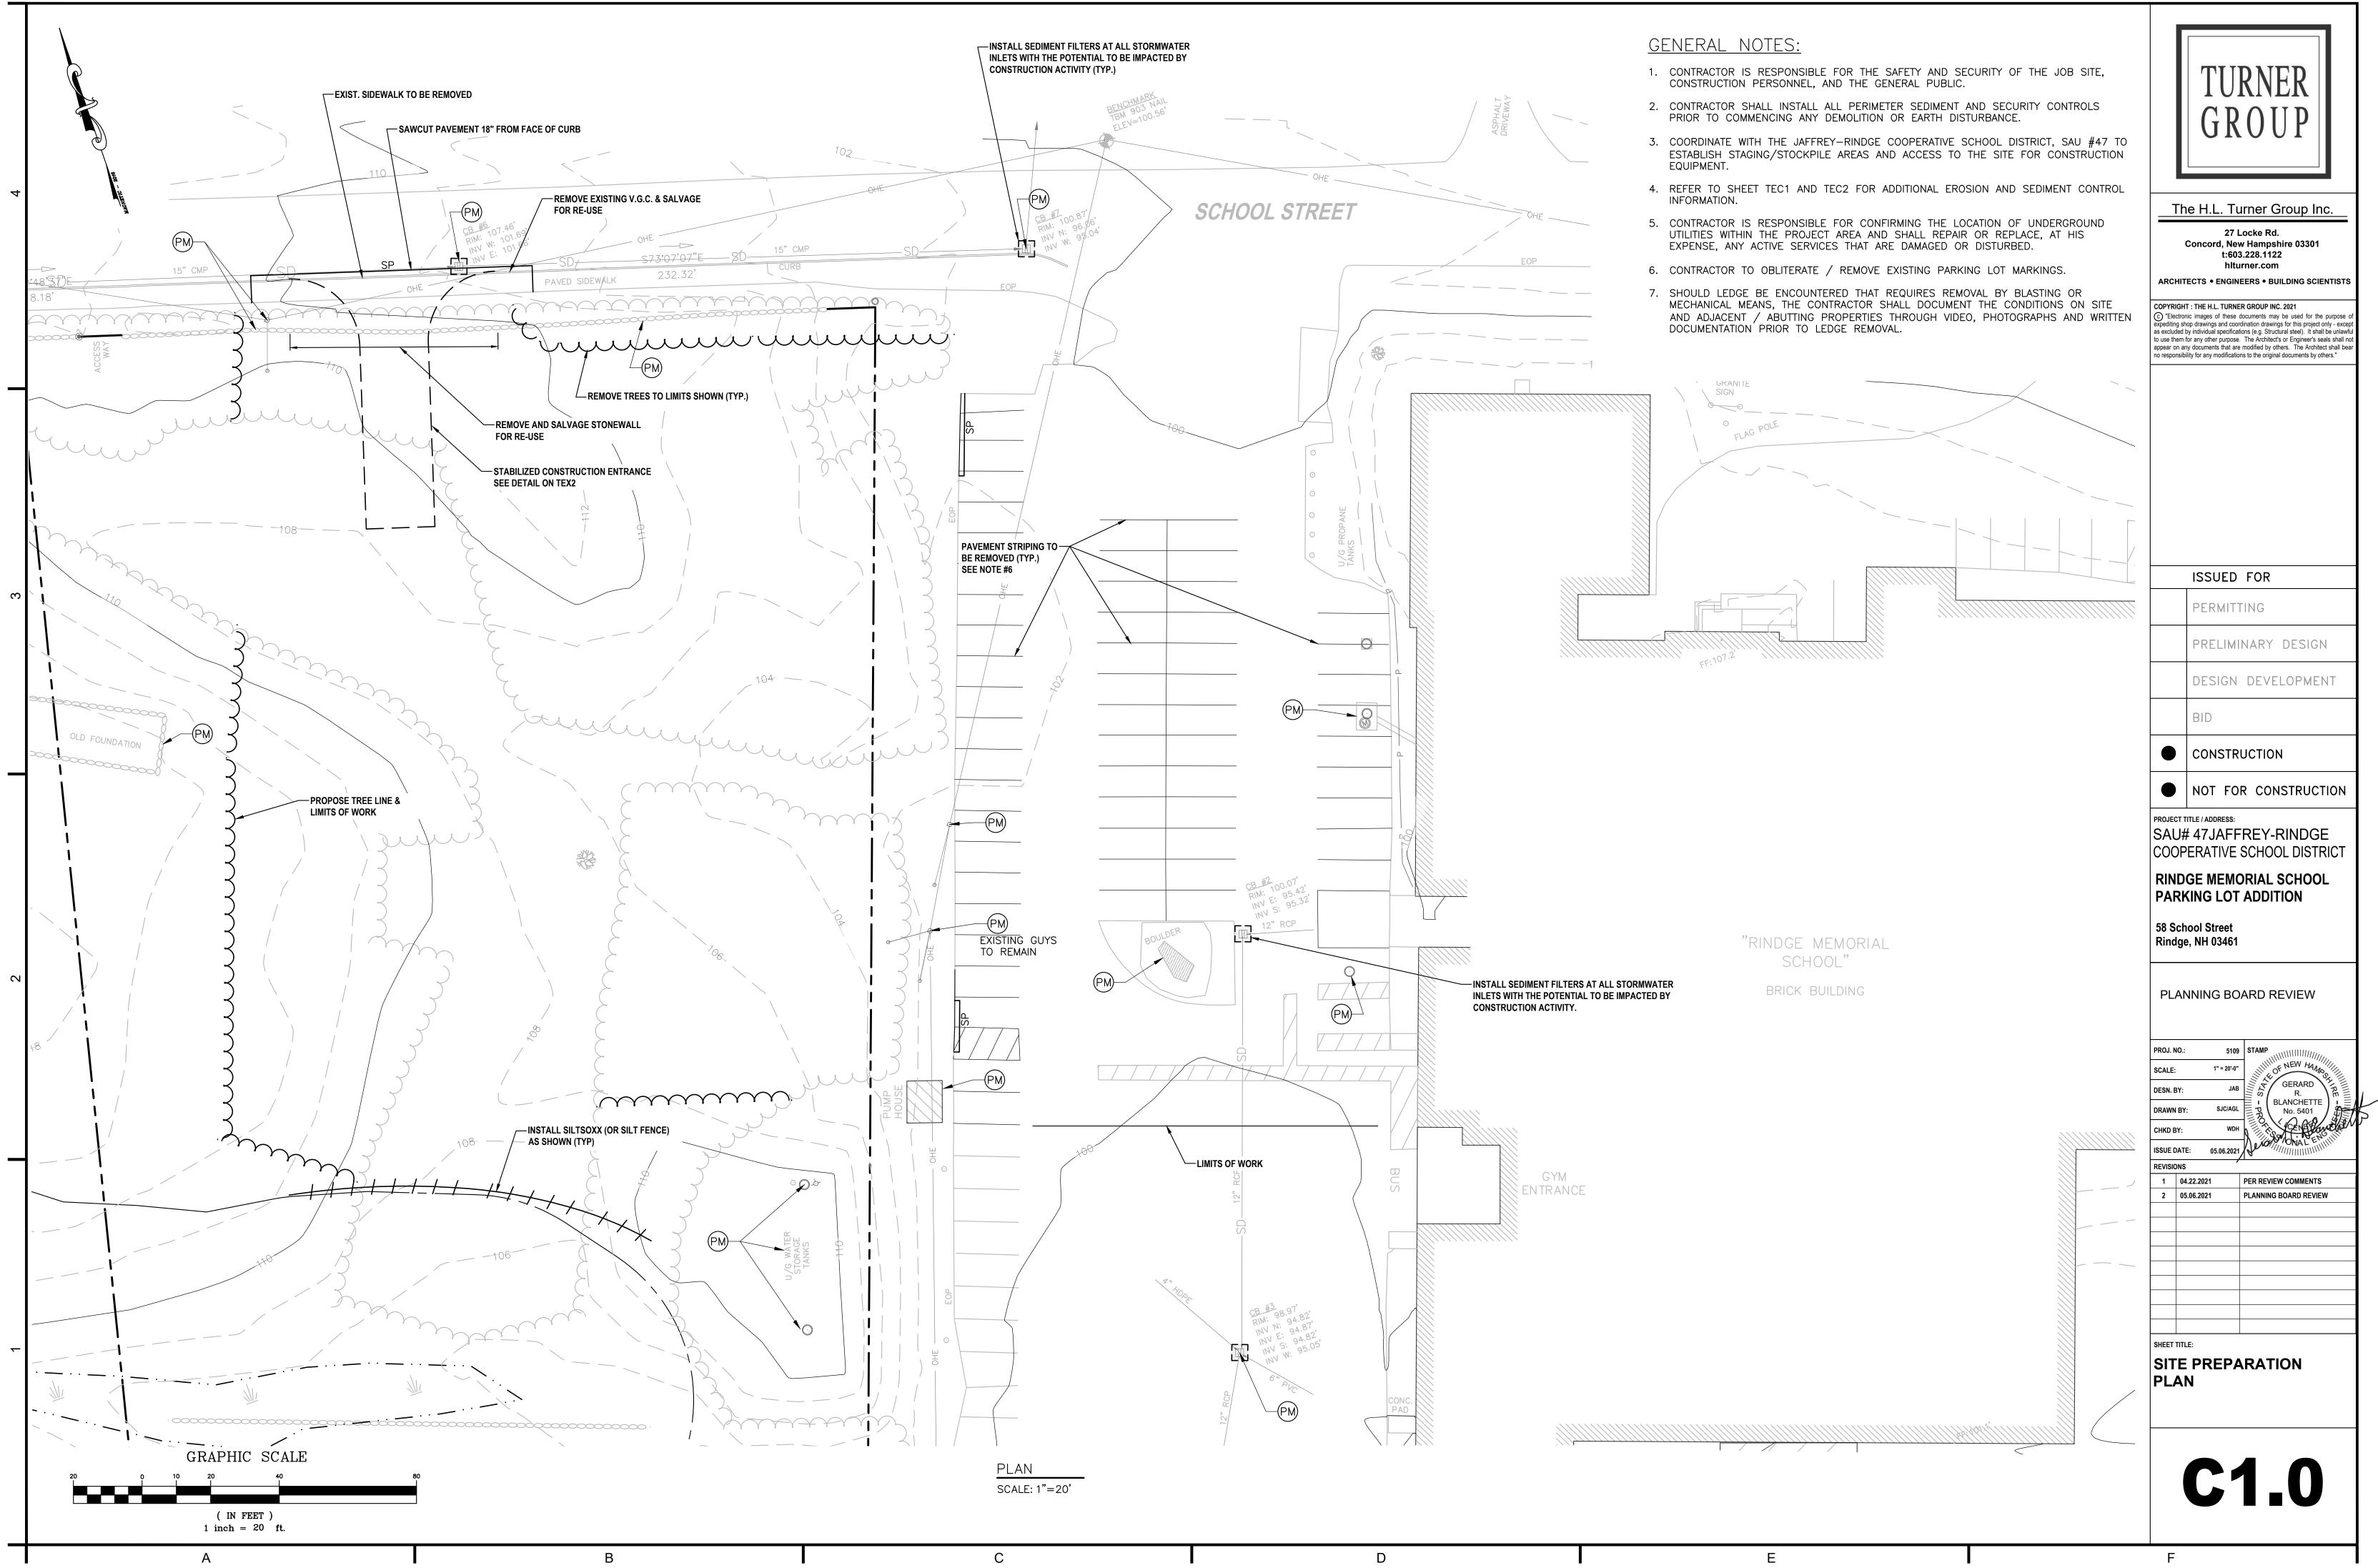
#### CAPE NOTES


CAPE PLAN (SHEET C5) NOT INCLUDED.

NTING OF SALVAGED LANDSCAPING TO BE COORDINATED WITH OWNER.







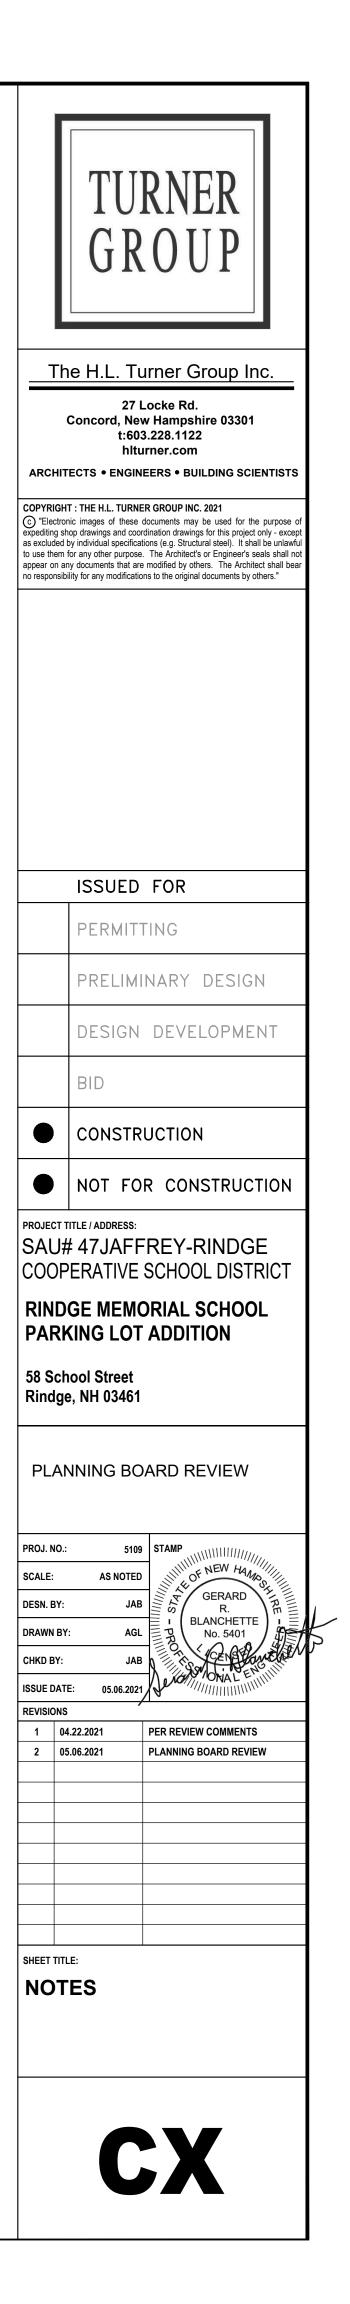

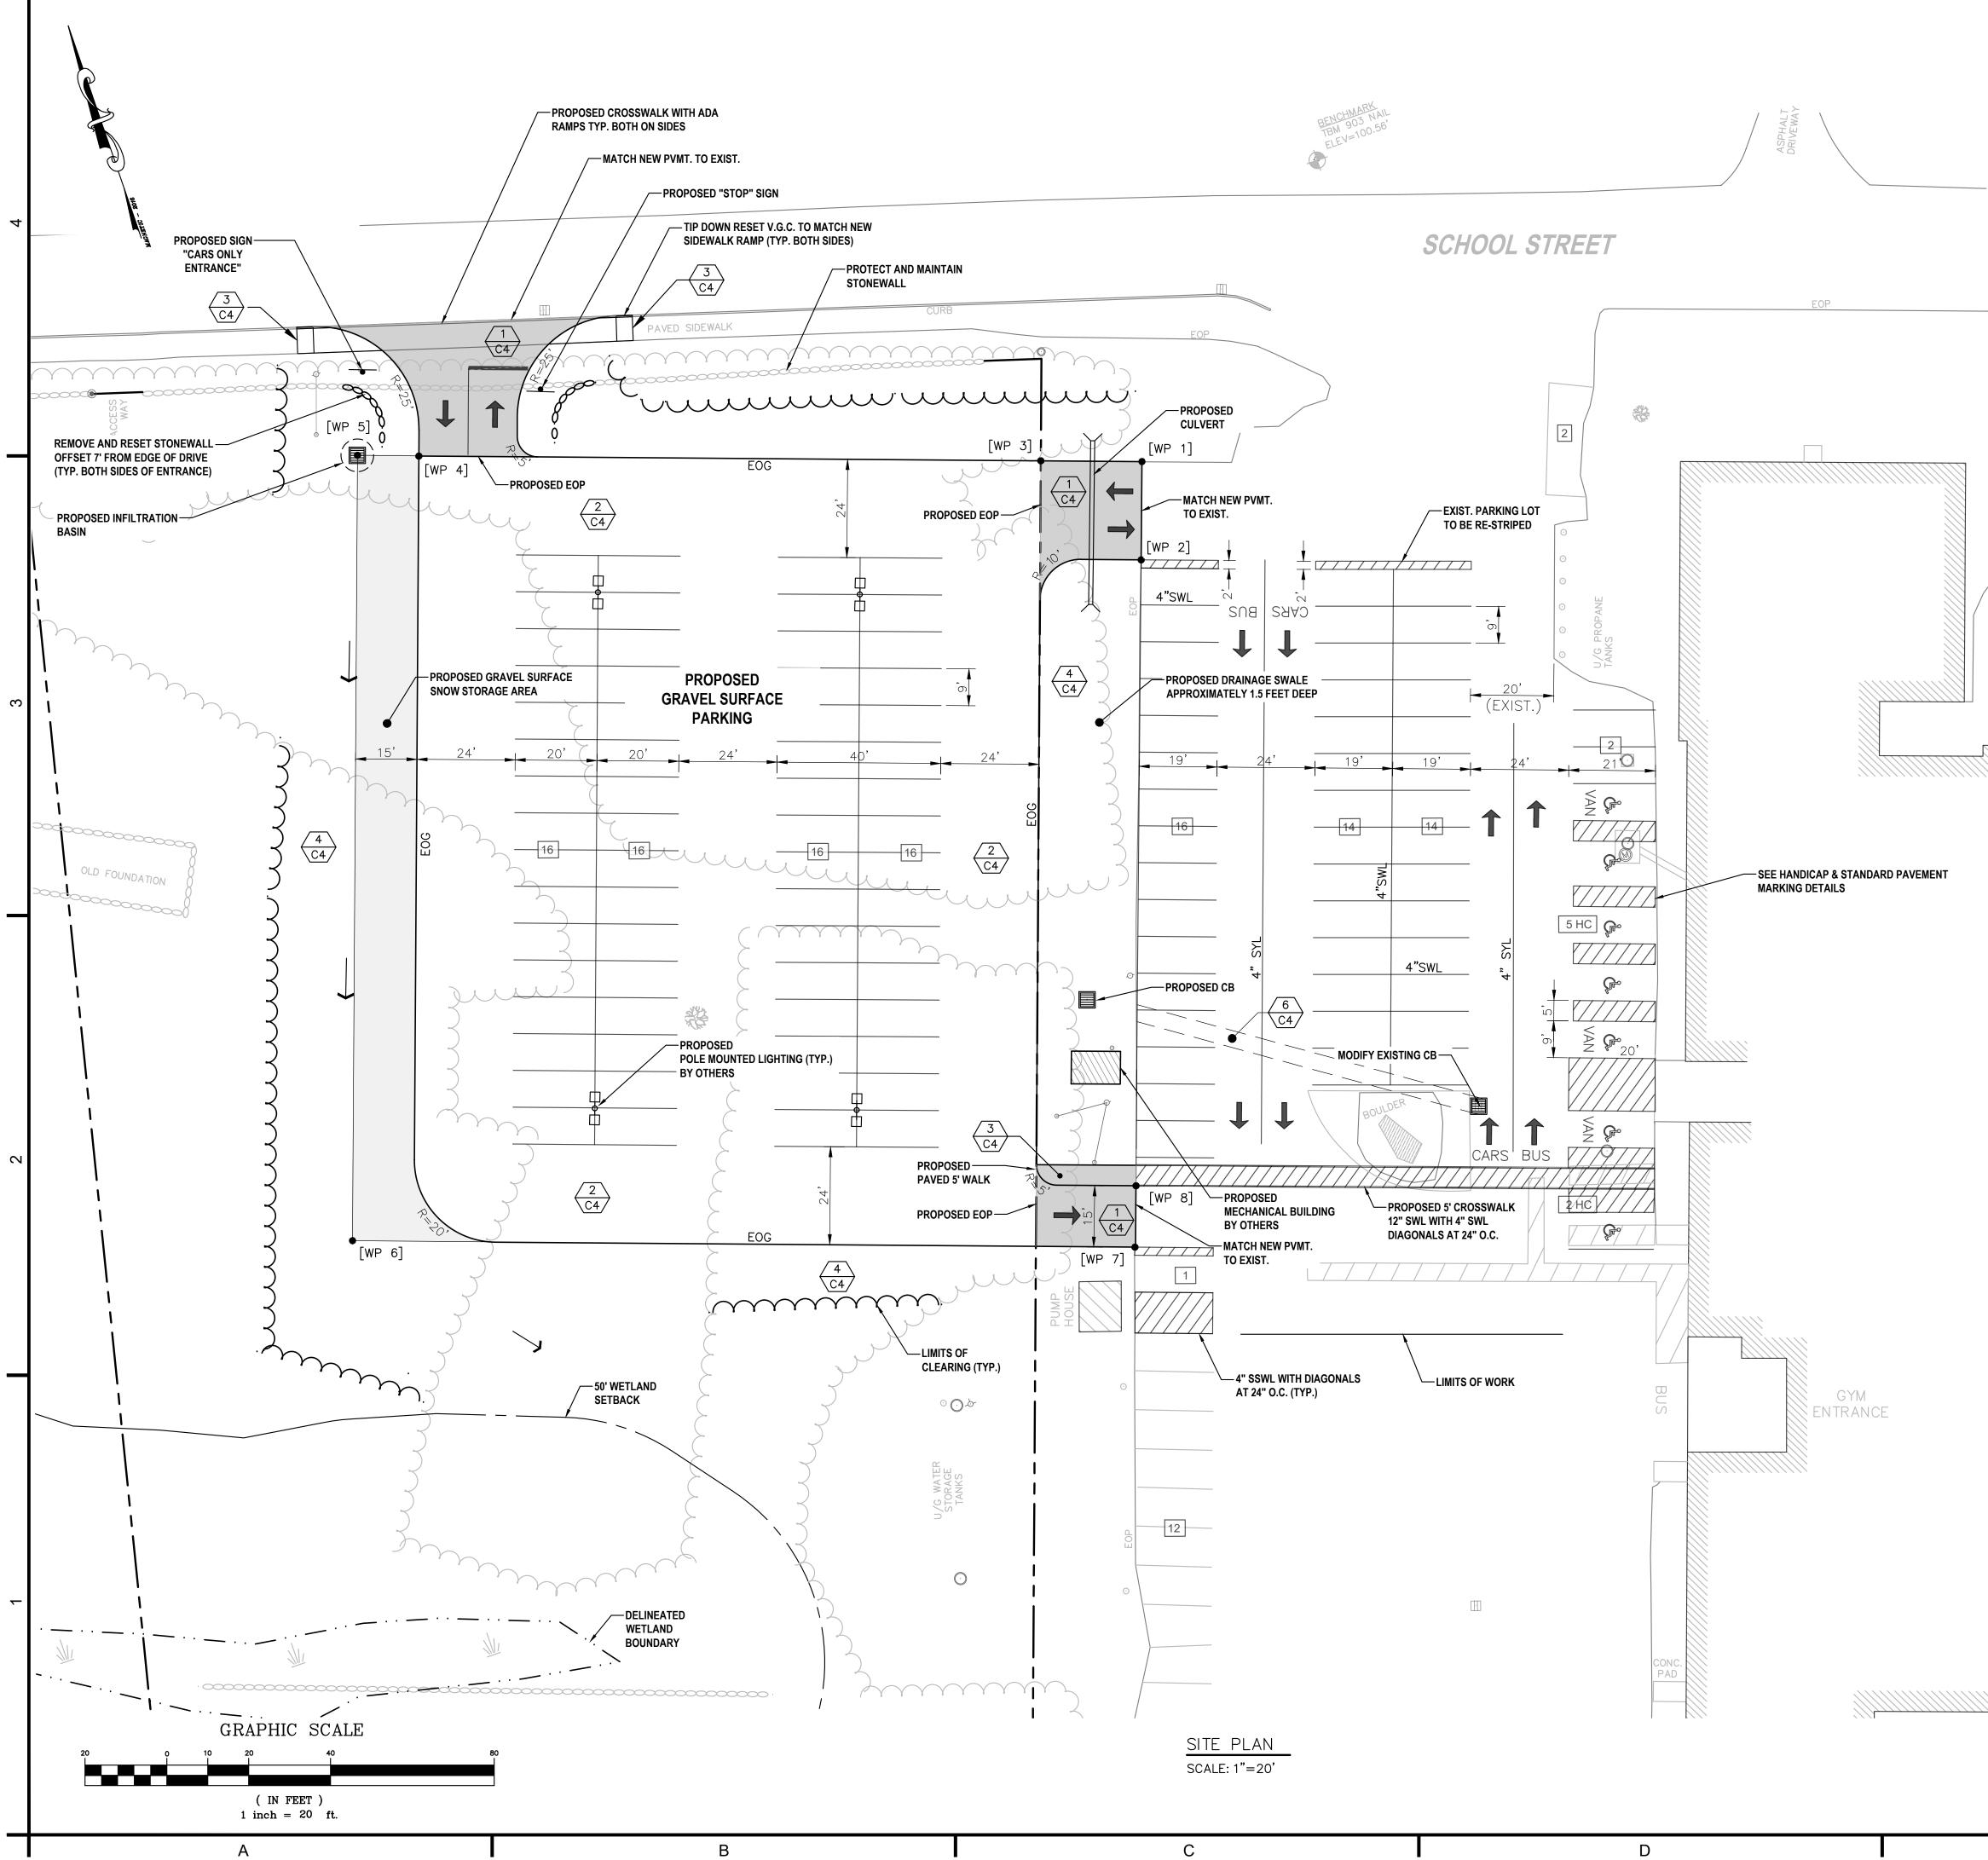


	PARKING N	IOTES:		
	EXISTING PAF	RKING SPACES:		TURNER
	EXISTING	85		
	<u>EXISTING</u> TOTAL EX		SPACES SPACES	GROUP
	PROPOSED P	ARKING SPACES:		
		TO REMAIN 16 MODIFIED 57		The H.L. Turner Group Inc.
		D ADDITIONAL 64	SPACES	27 Locke Rd. Concord, New Hampshire 03301 t:603.228.1122
	ADA	7	SPACES	ARCHITECTS • ENGINEERS • BUILDING SCIENTISTS
	TOTAL	144	4 SPACES	COPYRIGHT : THE H.L. TURNER GROUP INC. 2021
	(TOTAL SPAC	<u>,</u>		expediting shop drawings and coordination drawings for this project only - except as excluded by individual specifications (e.g. Structural steel). It shall be unlawful to use them for any other purpose. The Architect's or Engineer's seals shall not appear on any documents that are modified by others. The Architect shall bear
	PROPOSE EXISTING	-8	7 SPACES	no responsibility for any modifications to the original documents by others."
0	TOTAL AD	DED 57	7 SPACES	
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	3	10335.24 10010.2	28	
	4 5	10385.8         9866.9           10390.88         9852.8		SAU# 47JAFFREY-RINDGE
	6 7	10209.77 9789.1 10160.13 9974.5		COOPERATIVE SCHOOL DISTRICT RINDGE MEMORIAL SCHOOL
	8	10146.04 9969.4	6	PARKING LOT ADDITION
4.0	DOE MEMODIA	1		58 School Street Rindge, NH 03461
	DGE MEMORIA SCHOOL"			
"RIN[				PLANNING BOARD REVIEW
	RICK BUILDING			
	RICK BUILDING			
	RICK BUILDING			PROJ. NO.:         5109         STAMP           VIIIII NEW Has         NEW Has
	SHEET LEC	<u>Send</u>		SCALE:     1" = 20'-0"       DESN. BY:     JAB       DRAWN BY:     SJC/AGL
	SHEET LEC			SCALE:     1" = 20'-0"       DESN. BY:     JAB       JAB     K       GERARD       R.       BLANCHETTE
	SHEET LEC	CATCH BASIN		SCALE:     1" = 20'-0"       DESN. BY:     JAB       DRAWN BY:     SJC/AGL       CHKD BY:     WDH
	SHEET LEC			SCALE:     1" = 20'-0"       DESN. BY:     JAB       DRAWN BY:     SJC/AGL       CHKD BY:     WDH       ISSUE DATE:     05.06.2021
	SHEET LEC	CATCH BASIN CULVERT		SCALE:     1" = 20'-0"       DESN. BY:     JAB       DRAWN BY:     SJC/AGL       CHKD BY:     WDH       ISSUE DATE:     05.06.2021       REVISIONS       1     04.22.2021
	SHEET LEC PROPOSED	CATCH BASIN CULVERT SIGNAGE SITE LIGHTING PAVMENT MARKING		SCALE:     1" = 20'-0"       DESN. BY:     JAB       DRAWN BY:     SJC/AGL       CHKD BY:     WDH       ISSUE DATE:     05.06.2021       REVISIONS       1     04.22.2021
	SYL	CATCH BASIN CULVERT SIGNAGE SITE LIGHTING PAVMENT MARKING SINGLE YELLOW LINE		SCALE:     1" = 20'-0"       DESN. BY:     JAB       DRAWN BY:     SJC/AGL       CHKD BY:     WDH       ISSUE DATE:     05.06.2021       REVISIONS       1     04.22.2021
	SHEET LEC PROPOSED	CATCH BASIN CULVERT SIGNAGE SITE LIGHTING PAVMENT MARKING		SCALE:     1" = 20'-0"       DESN. BY:     JAB       DRAWN BY:     SJC/AGL       CHKD BY:     WDH       ISSUE DATE:     05.06.2021       REVISIONS       1     04.22.2021
	SHEET LEC PROPOSED	CATCH BASIN CULVERT SIGNAGE SITE LIGHTING PAVMENT MARKING SINGLE YELLOW LINE SINGLE WHITE LINE PARKING COUNT		SCALE:       1" = 20'-0"         DESN. BY:       JAB         DRAWN BY:       SJC/AGL         CHKD BY:       WDH         ISSUE DATE:       05.06.2021         REVISIONS         1       04.22.2021         PER REVIEW COMMENTS         2       05.06.2021         PLANNING BOARD REVIEW         Image: Date:       Image: Date:         Image: Date:       05.06.2021         PER REVIEW COMMENTS       Image: Date:         Image: Date:       Image: Date:
	SHEET LEC PROPOSED	CATCH BASIN CULVERT SIGNAGE SITE LIGHTING PAVMENT MARKING SINGLE YELLOW LINE SINGLE WHITE LINE PARKING COUNT	Т	SCALE:     1" = 20'-0"       DESN. BY:     JAB       DRAWN BY:     SJC/AGL       CHKD BY:     WDH       ISSUE DATE:     05.06.2021       PER REVIEW COMMENTS       2     05.06.2021       PLANNING BOARD REVIEW
	SHEET LEC PROPOSED	CATCH BASIN CULVERT SIGNAGE SITE LIGHTING PAVMENT MARKING SINGLE YELLOW LINE SINGLE WHITE LINE PARKING COUNT	Т	SCALE:       1" = 20'-0"         DESN. BY:       JAB         DRAWN BY:       SJC/AGL         CHKD BY:       WDH         ISSUE DATE:       05.06.2021         REVISIONS         1       04.22.2021         PER REVIEW COMMENTS         2       05.06.2021         PLANNING BOARD REVIEW         Image: Sheet Title:

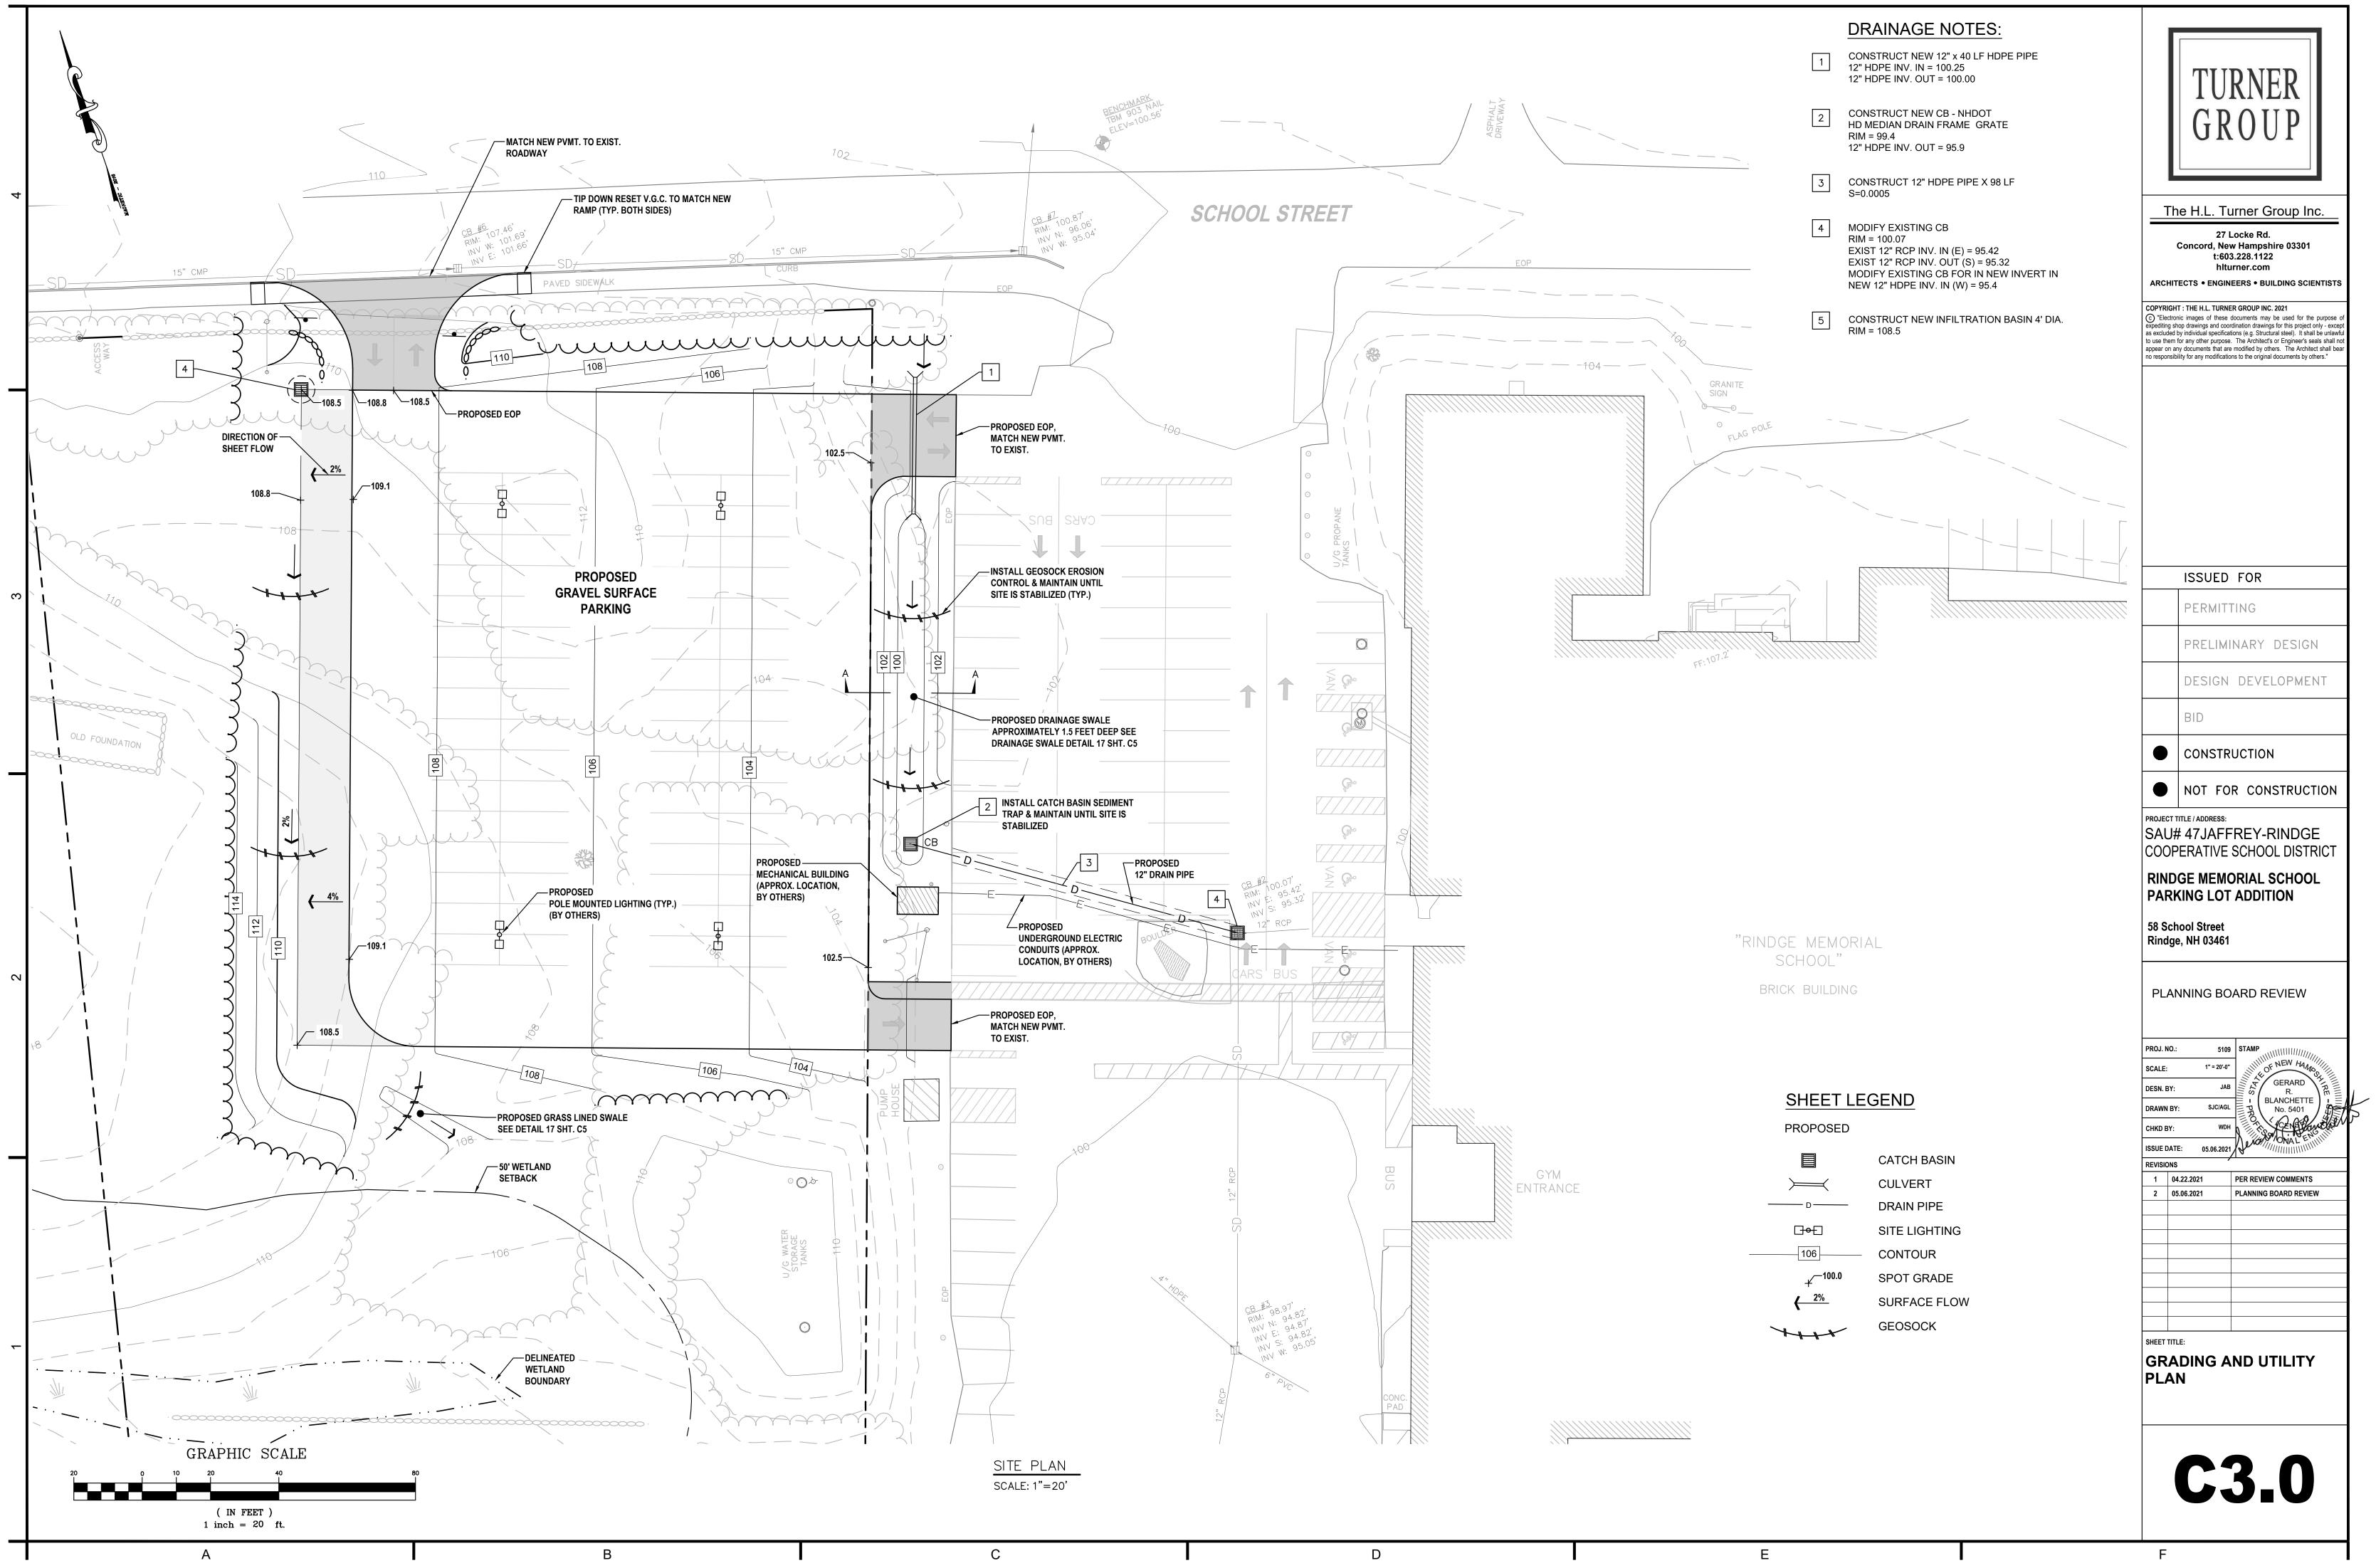


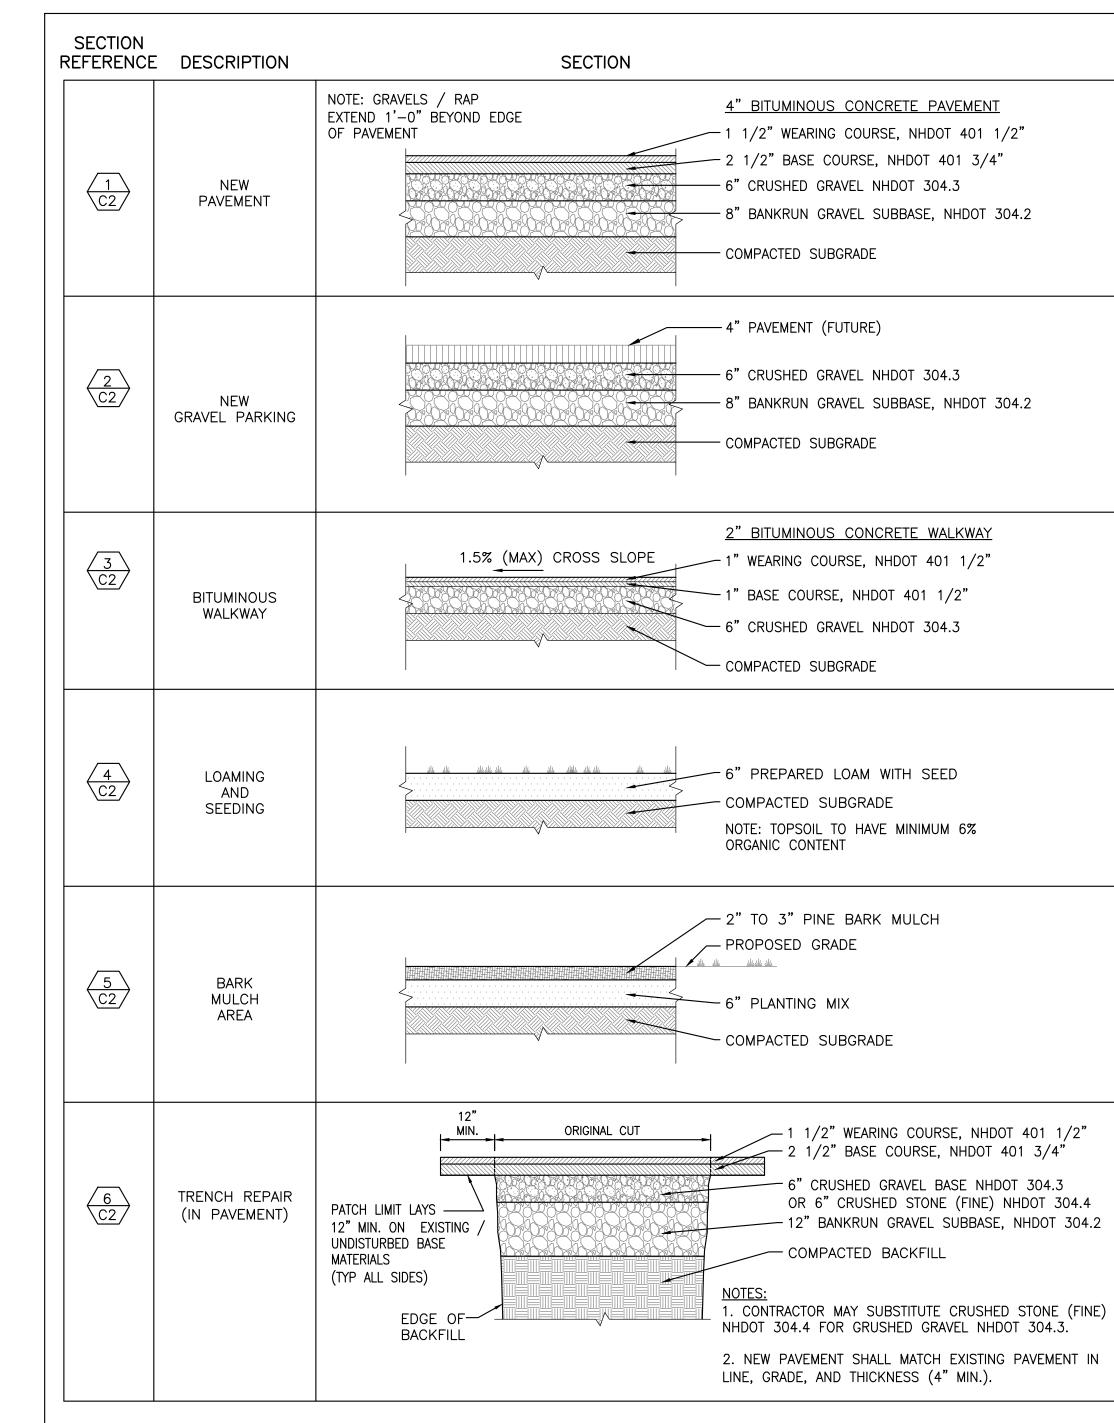

NOTE: THESE TYPICAL SECTIONS OF SURFACE TREATMENTS CAN BE FOUND ON SHEET C2

TYPICAL SECTIONS OF SURFACE TREATMENTS C2 SCALE: NONE

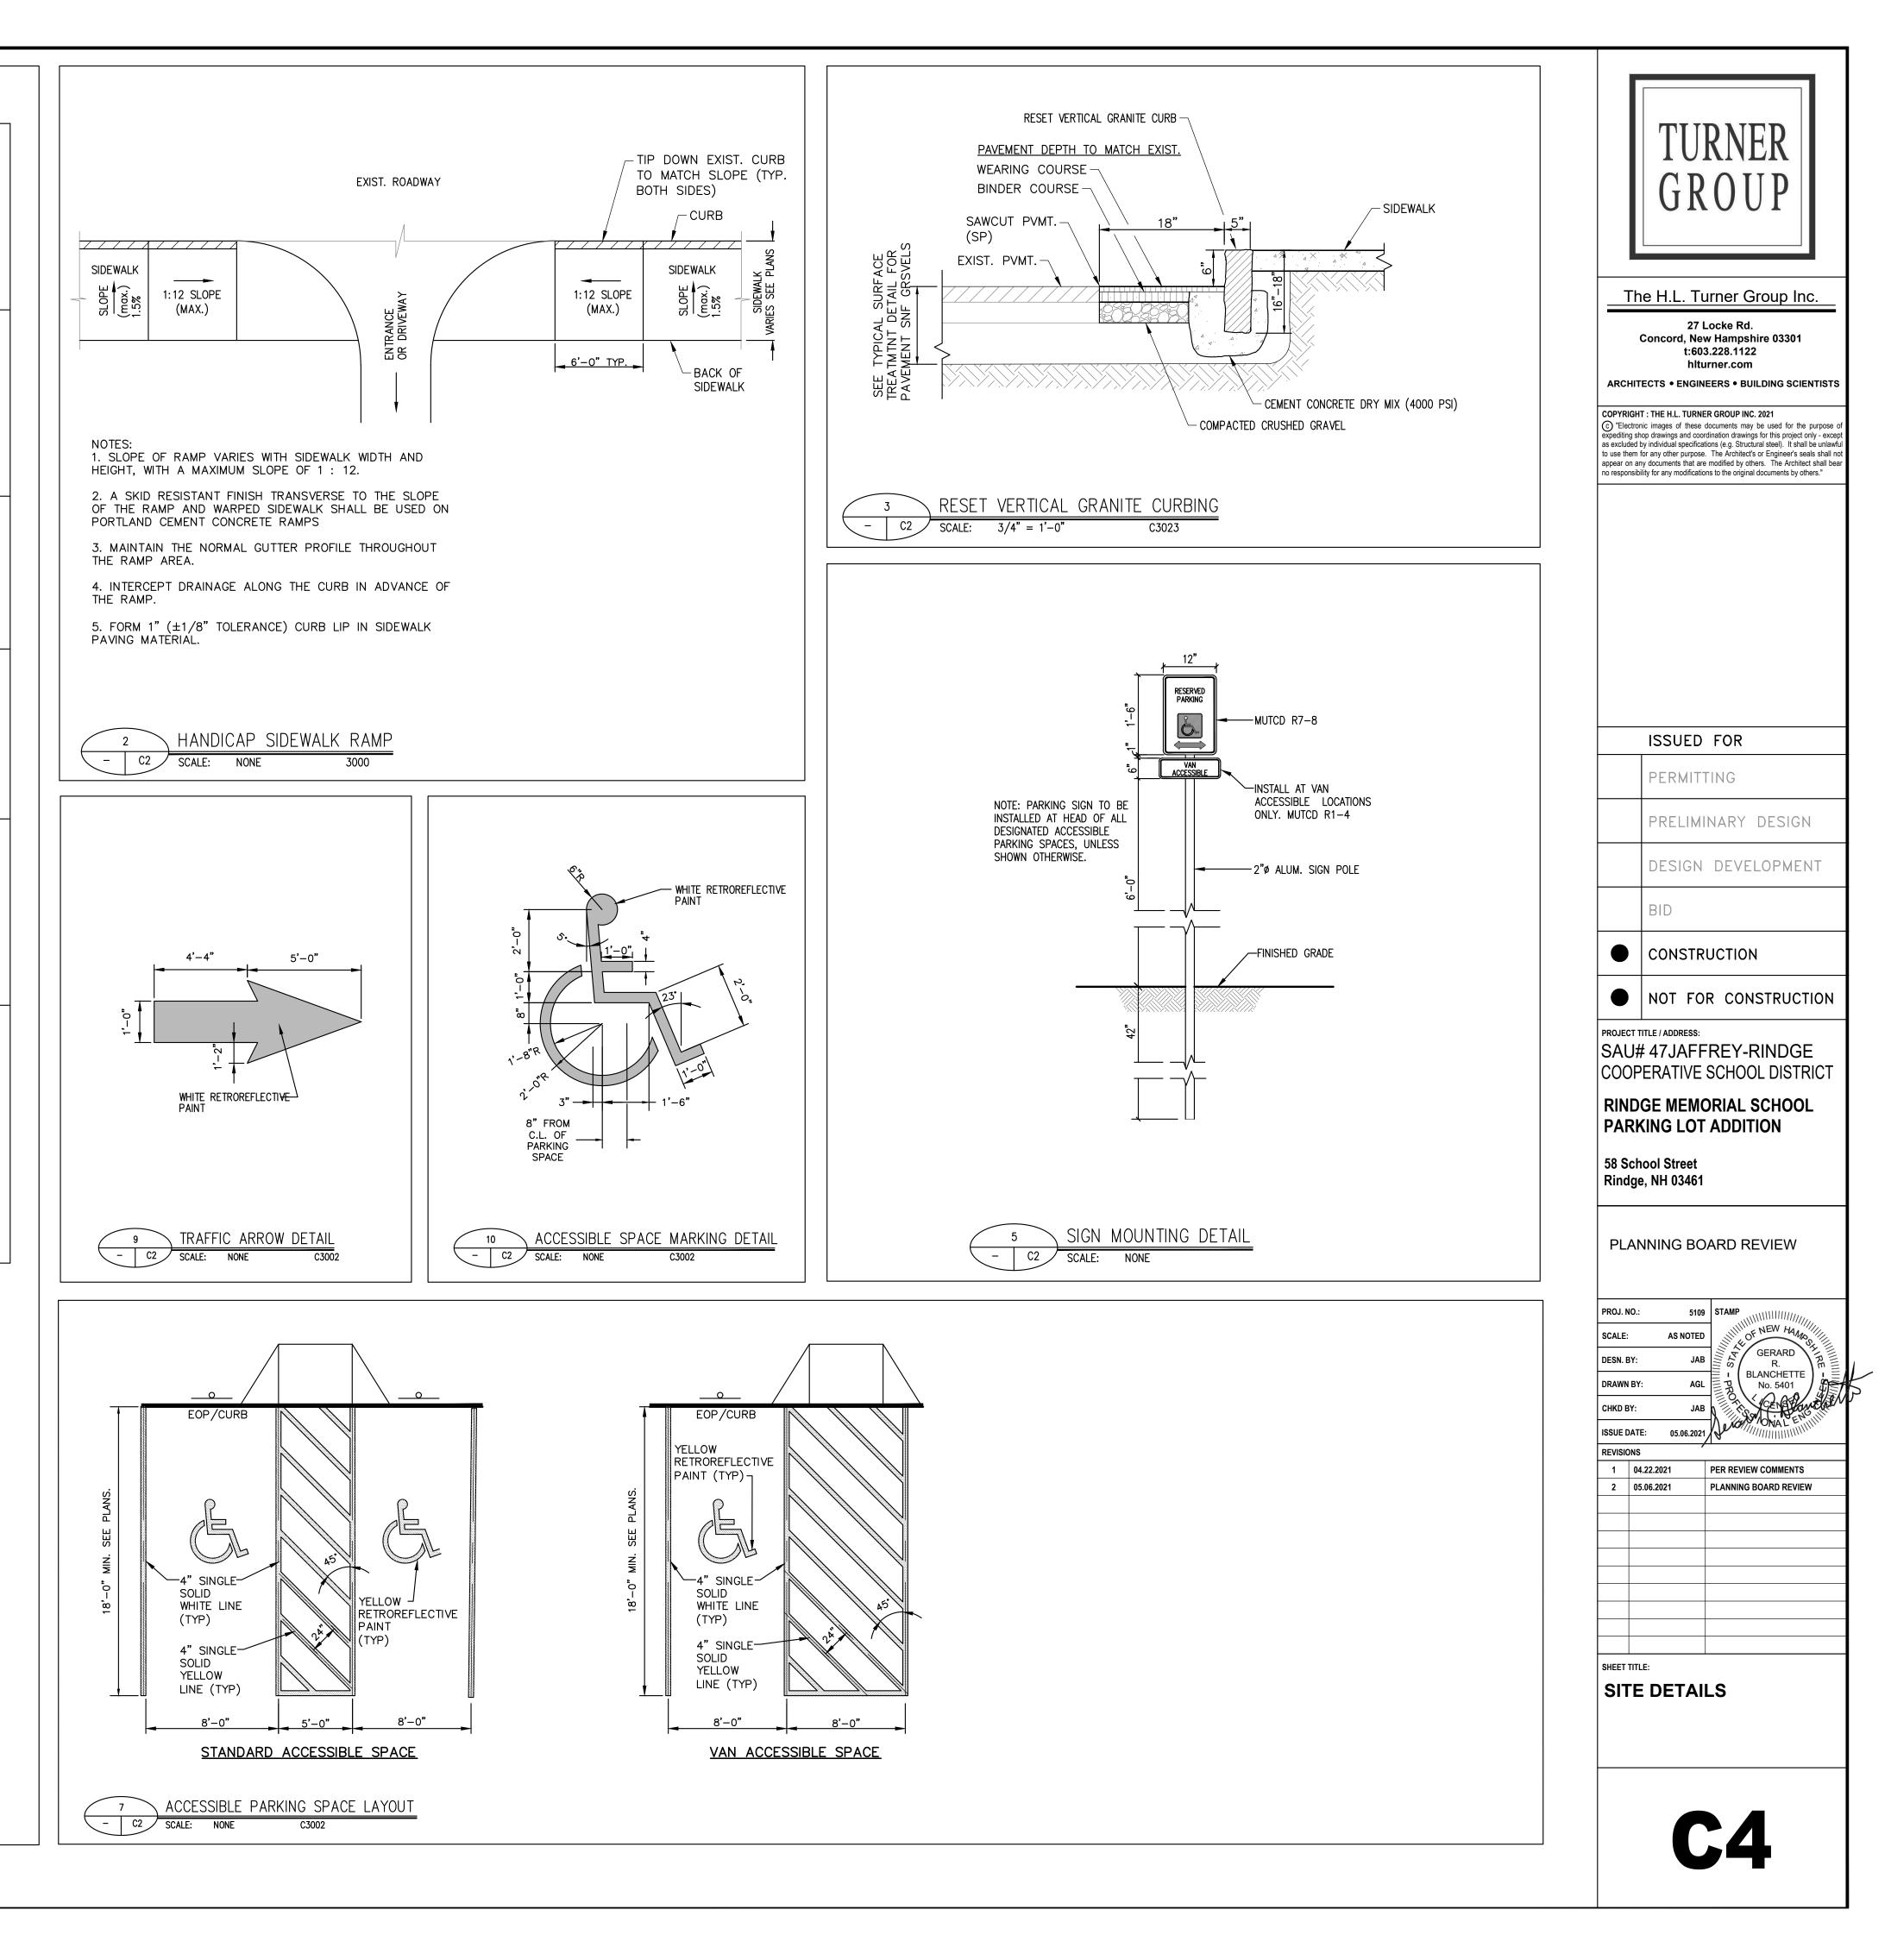

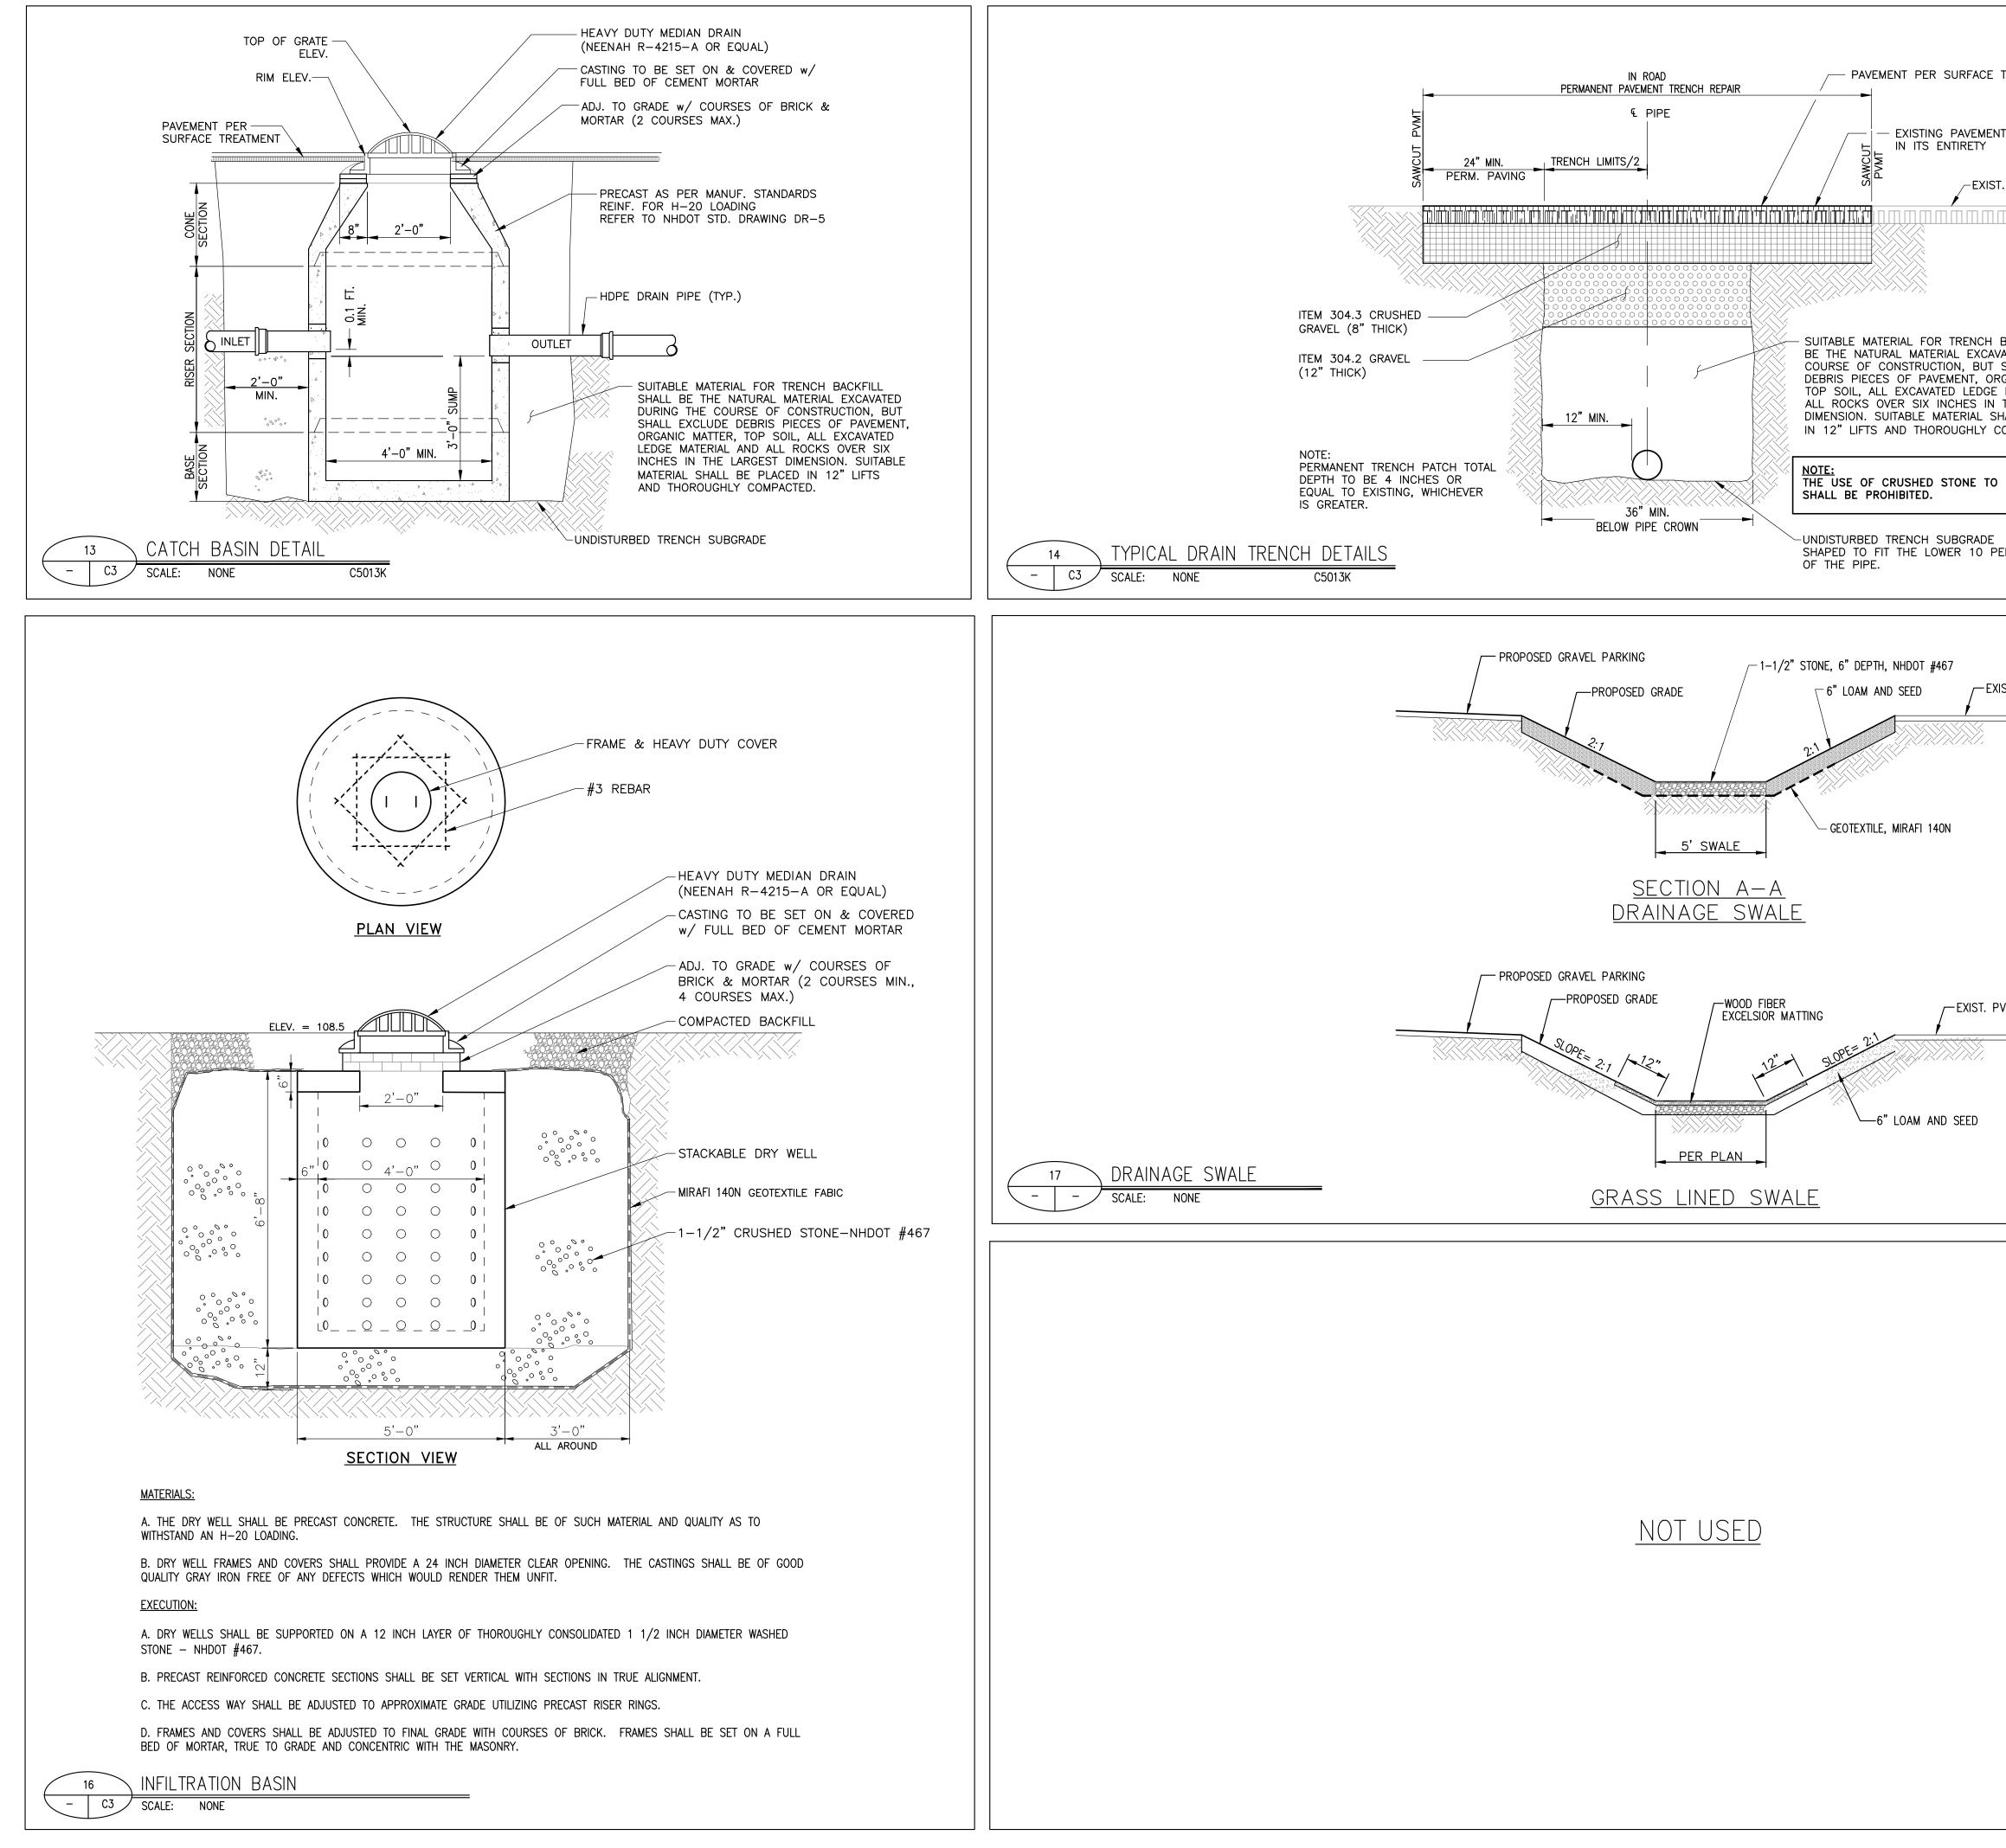

TREATMENTS IT TO BE REMOVED T. PAVEMENT BACKFILL SHALL ATED DURING THE SHALL EXCLUDE SCANIC MATER, MATERIAL AND THE LARGEST HALL BE PLACED COMPACTED. BED DRAIN PIPES	CO exp as c to u app	ARCHI OPYRIG ) "Electr pediting excluded use ther use ther use ther	HE H.L. TU Concord, Nev t:600 htt ITECTS • ENGIN HT : THE H.L. TURNI ronic images of these shop drawings and coo d by individual specifica n for any other purpose any documents that ar	International and the properties of the propes of the original documents by others.
ERCENT				
			ISSUED	FOR
ST. PVMT.			PERMIT	
			PRELIM	INARY DESIGN
			DESIGN	DEVELOPMENT
			BID	
		•	CONSTR	UCTION
		•	NOT FO	R CONSTRUCTION
MT. 	S. Cu R 54 R	SAU SOO RINE PAR	PERATIVE DGE MEMO KING LOT shool Street ge, NH 03461	REY-RINDGE SCHOOL DISTRICT
	SC. DE: DR. CH	ROJ. NO CALE: ESN. BY RAWN B	BY: AGL	GERARD R. BLANCHETTE No. 5401
	RE	SUE DA		
			05.06.2021	PLANNING BOARD REVIEW
		HEET TI		AGE DETAILS
			C	;5